NORTH CAMPUS CONDITIONAL USE PERMIT PROJECT

CAMERON McCARTHY

LANDSCAPE ARCHITECTURE & PLANNING

160 East Broadway ■ Eugene Oregon 97401


v 541.485.7385 f 541.485.7389

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DESCRIPTION

The master site plan is a set of drawings that establishes a regulatory framework and demonstrates compliance with the code and additional restrictions that the university chooses to impose on itself. It is required by the zoning code and serves as the framework for this Conditional Use Permit proposal. The master site plan set contains a regulatory plan, a conceptual site plan showing a scenario of potential maximum or likely development, and conceptual plans for pedestrian and bicycle, vehicle, and service vehicle primary circulation. Supporting documents include an existing conditions plan and conceptual plans for utilities.

VICINITY MAP

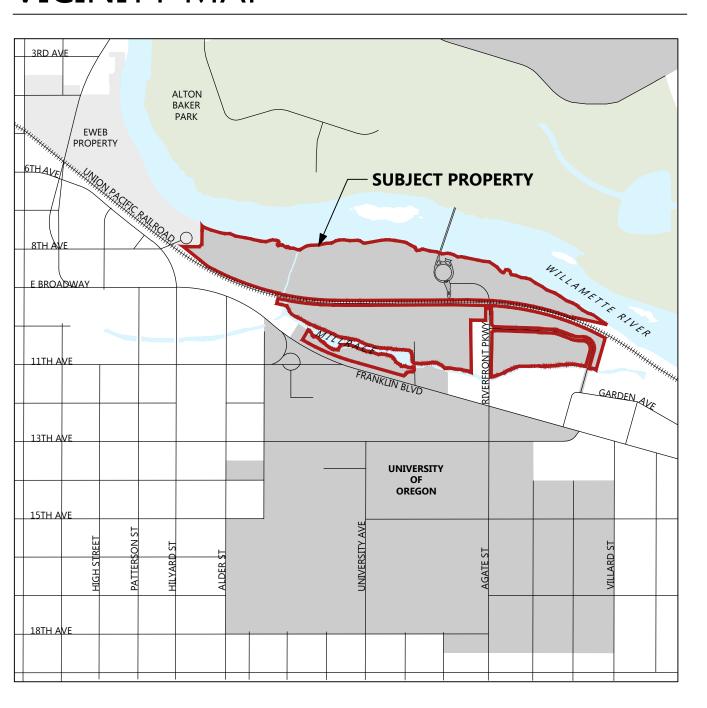

SHEET INDEX

GENERAL

G00 COVER SHEET

SURVEY

S01 EXISTING CONDITIONS

LANDSCAPE ARCHITECTURE

- L01 MASTER SITE PLAN REGULATORY PLAN
- LO2 MASTER SITE PLAN CONCEPTUAL SITE PLAN
 LO3 MASTER SITE PLAN PEDESTRIAN AND BICYCLE PLAN
- .03 MASTER SITE PLAN PEDESTRIAN AND BICYCLE PLAN .04 MASTER SITE PLAN - PRIVATE VEHICLE PLAN
- LO5 MASTER SITE PLAN SERVICE VEHICLE PLAN

CIVIL

- C01 STORM DRAINAGE PLAN
- C02 SANITARY SEWER PLAN
- CO3 WATER SUPPLY PLAN

PROJECT INFORMATION

TAX LOT

17033221-0300 17033214-1800 17033224-5300 17033214-2300

17033214-0103 17033214-2200 17033214-1400

17033214-2000 17033214-1100 17033214-0105

17033214-1600 17033214-2500 17033214-2600 17033214-2400

17033214-2400 17033214-2700 17033214-0100

SITE ADDRESS

1276 UNIVERSITY OF OREGON 1295 FRANKLIN BOULEVARD EUGENE, OR 97403

PROPERTY SIZE

3,373,690 SF; 77.45 ACRES

PROJECT AREA

3,373,690 SF; 77.45 ACRES

PROJECT TEAM

OWNER

UNIVERSITY OF OREGON 1276 UNIVERSITY OF OREGON EUGENE, OR 97403 (541) 346-5606 CONTACT: EMILY ENG

PLANNER & LANDSCAPE ARCHITECT

CAMERON MCCARTHY LANDSCAPE ARCHITECTURE & PLANNING 160 E BROADWAY EUGENE, OR 97401 (541) 485-7385

(541) 785-7389 (FAX) CONTACT: COLIN MCARTHUR, AICP

CIVIL ENGINEER / SURVEYOR

BHEGroup 940 WILLAMETTE STREET, SUITE 310 EUGENE, OR 97401 (541) 686-8478 CONTACT: MONICA ANDERSON

ENVIRONMENTAL

MASON, BRUCE & GIRARD 707 SW WASHINGTON STREET, SUITE 1300 PORTLAND, OR 97205 (541) 224-3445 (541) 224-6524 (FAX) CONTACT: STUART MEYERS

TRANSPORTATION ENGINEER

KITTLESON & ASSOCIATES 610 SW ALDER STREET, SUITE 700 PORTLAND, OR 97205 (800) 878-5230 CONTACT: PHILL WORTH

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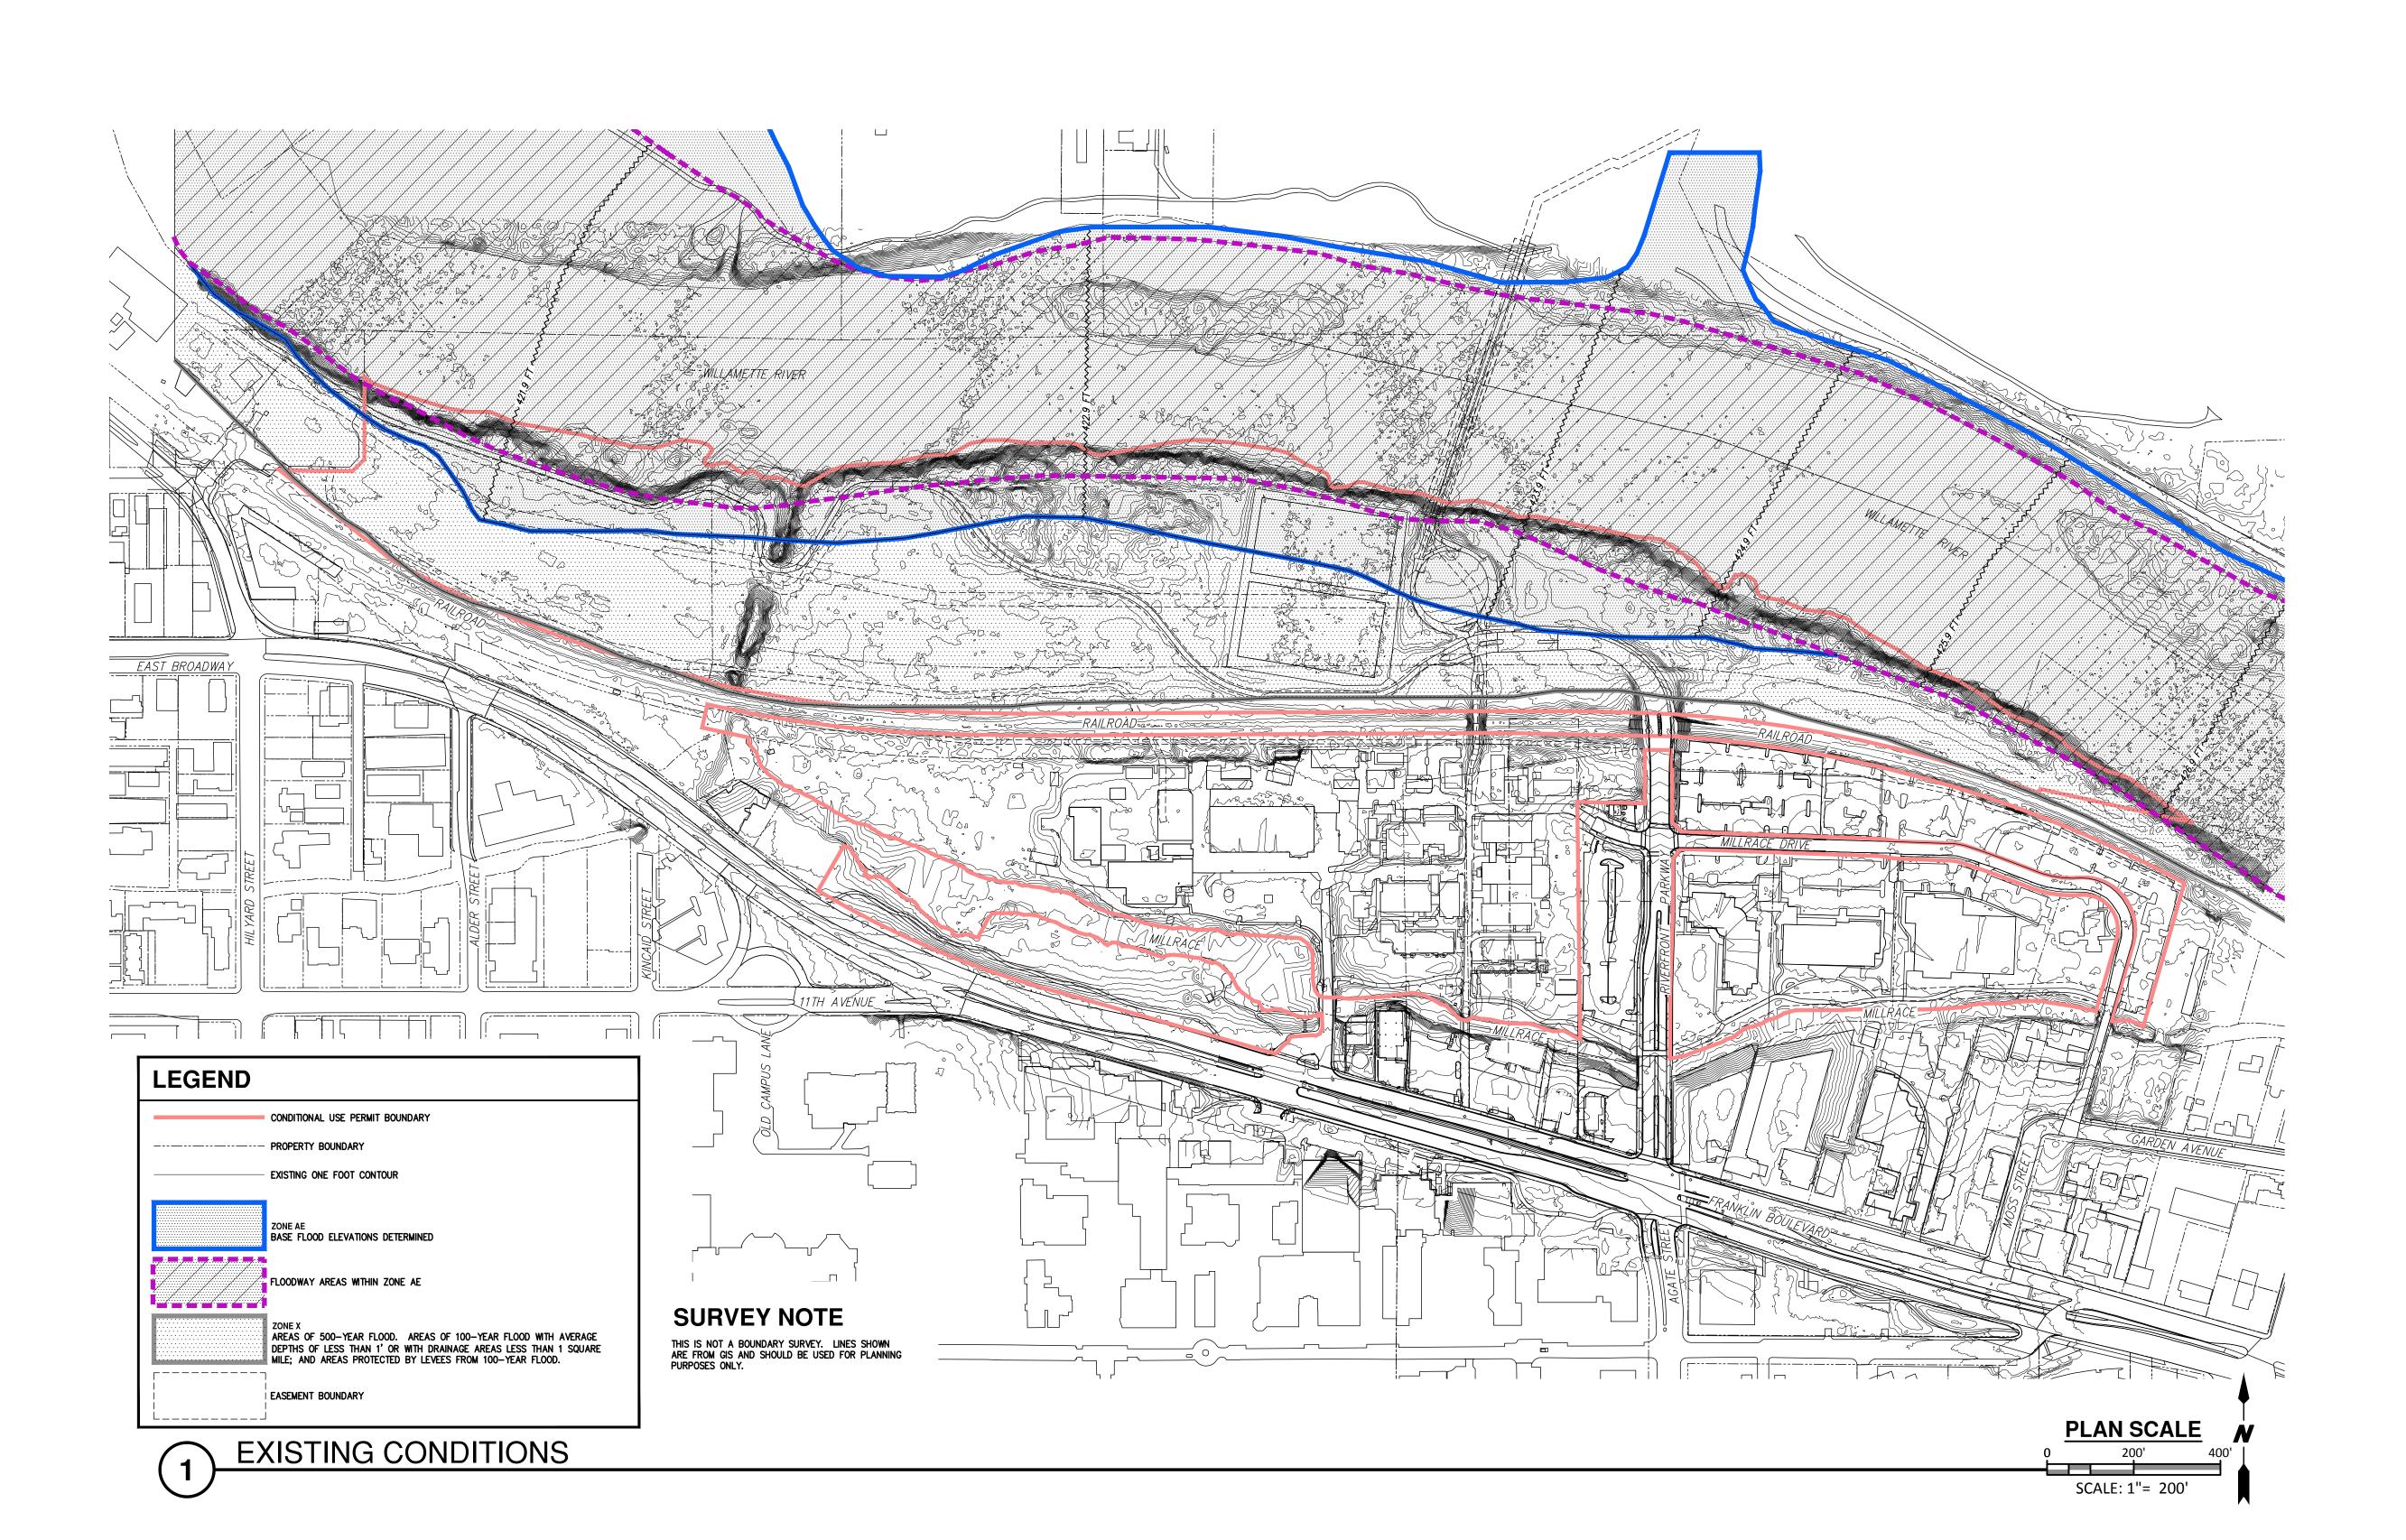
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SHEET TITLE

COVER SHEET

G00






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> LAND USE SUBMITTAL

SHEET TITLE

EXISTING CONDITIONS

SHEET #

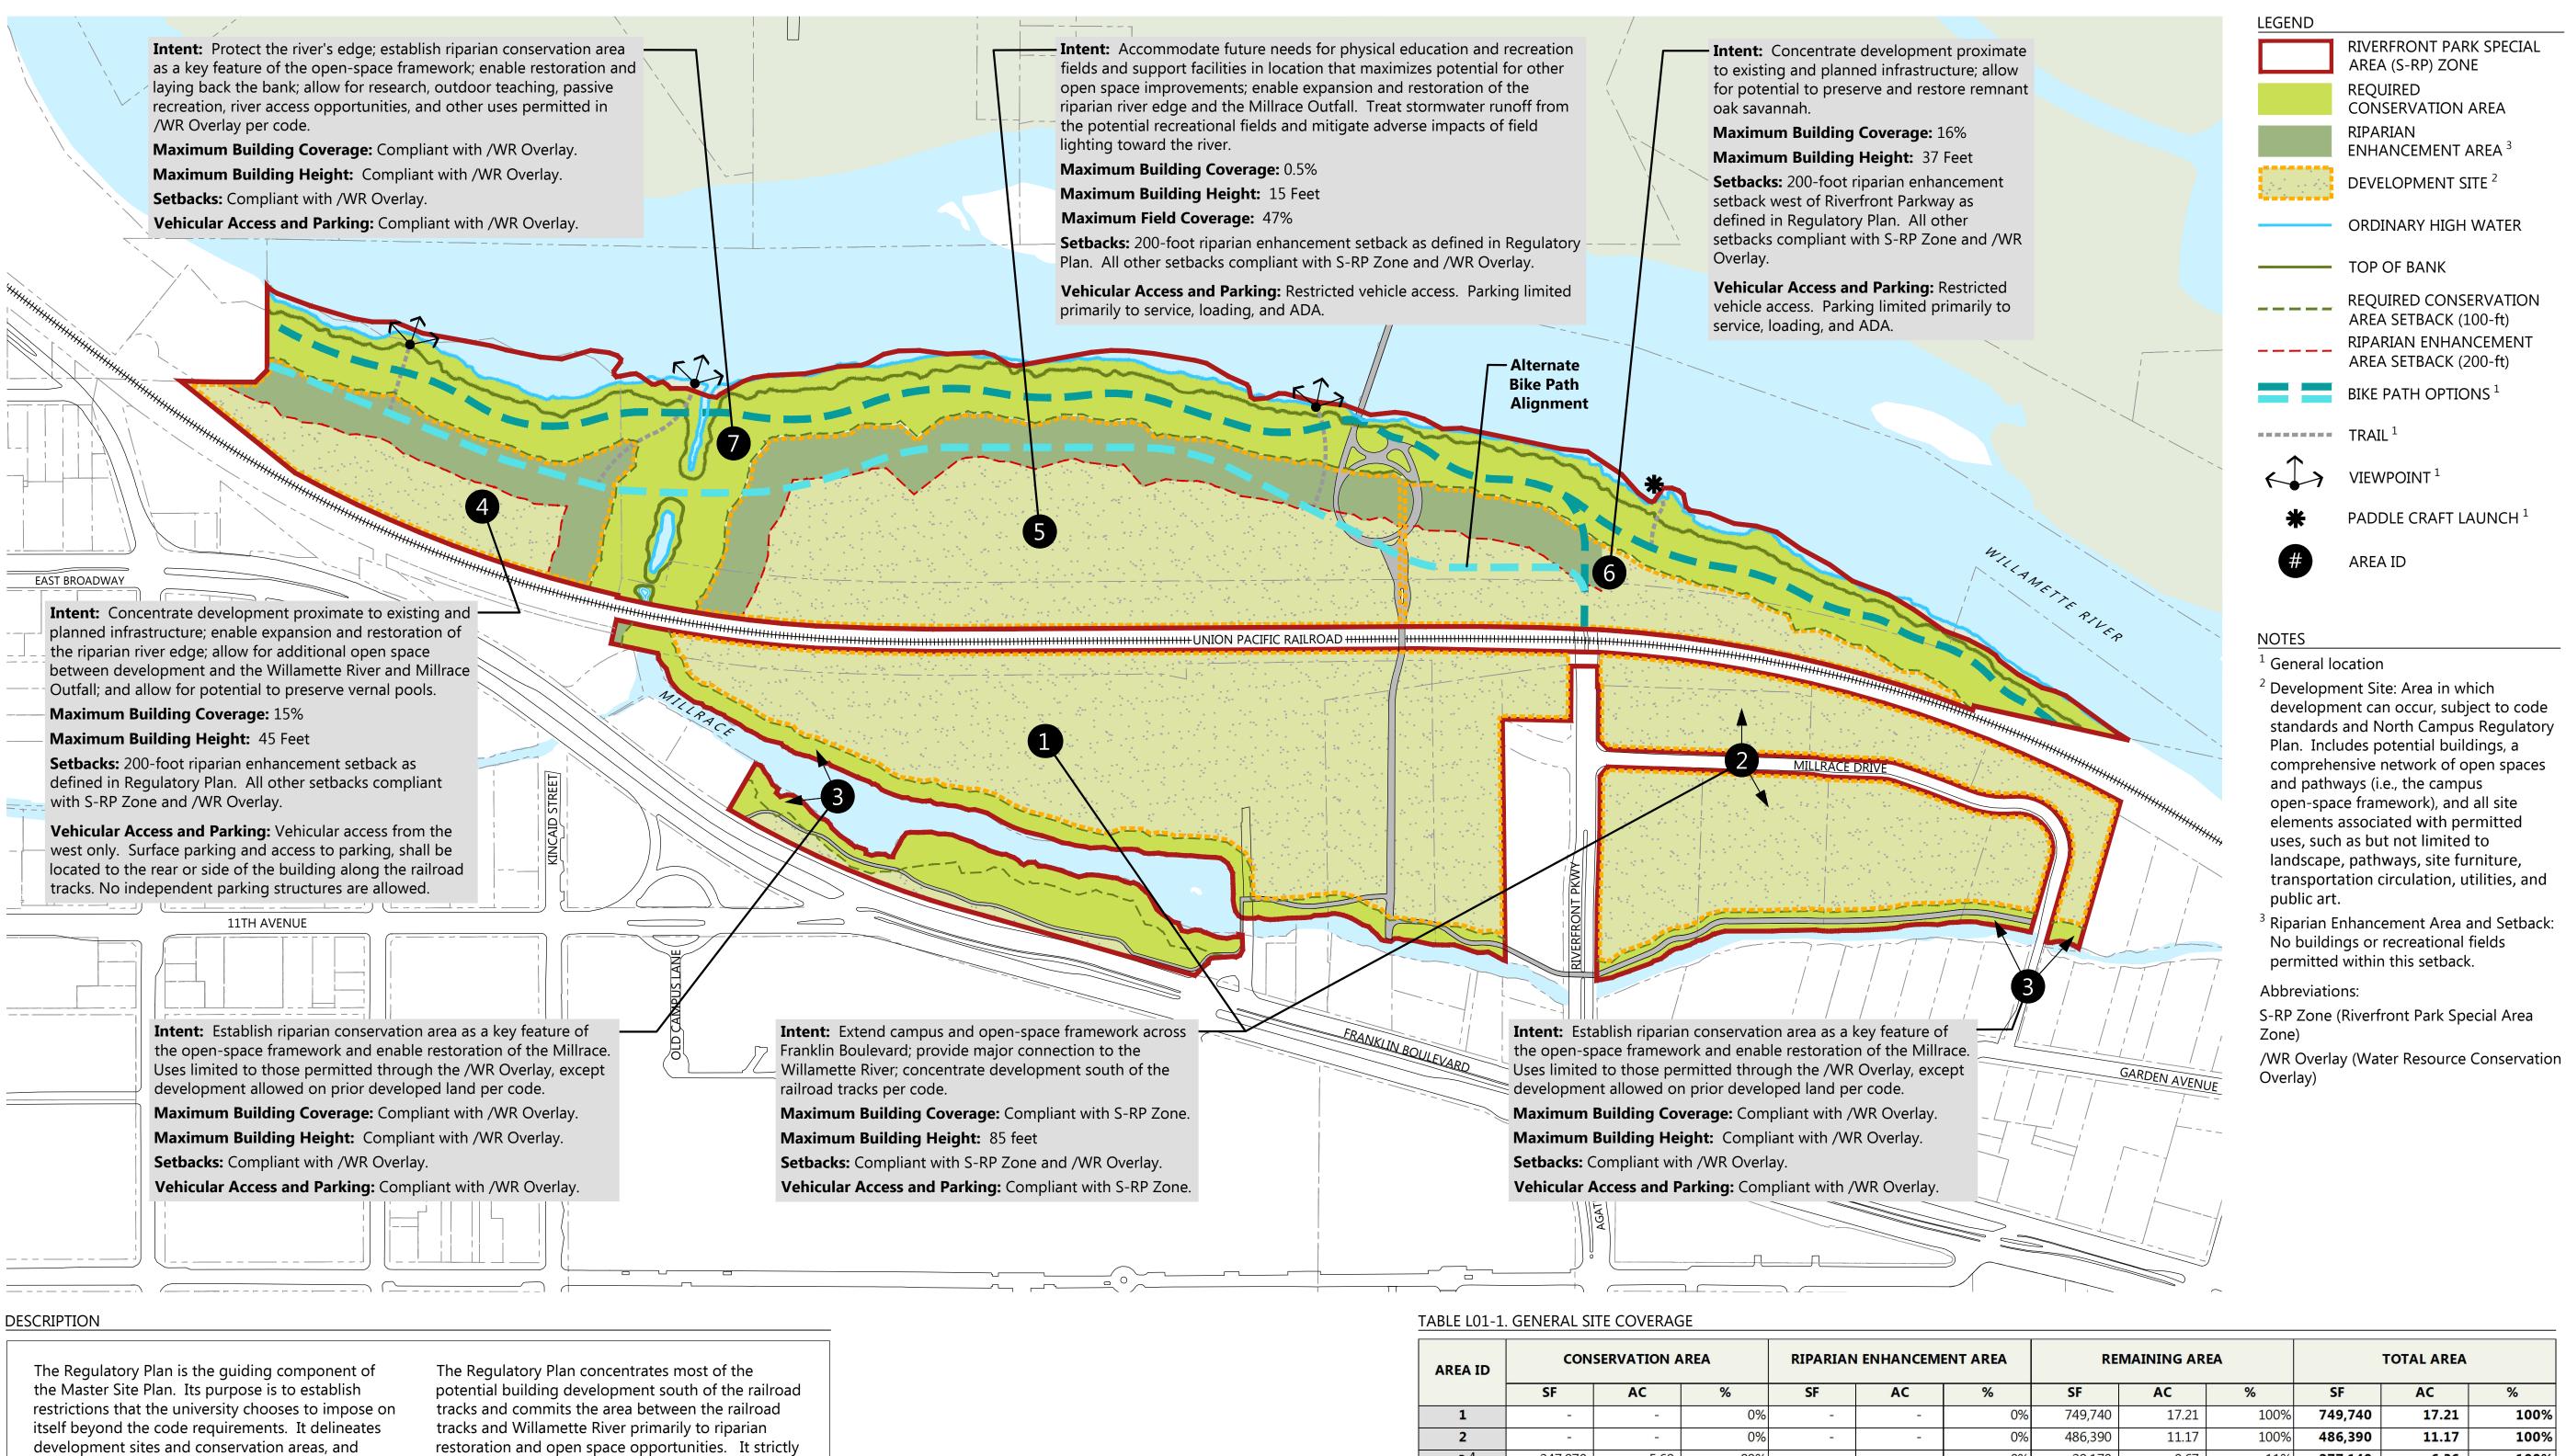

AREA ID	CONS	SERVATION A	REA	RIPARIAN	ENHANCEME	ENT AREA	RE	MAINING AR	EA	TOTAL AREA			
	SF	AC	%	SF	AC	%	SF	AC	%	SF	AC	%	
1	-	-	0%	-	-	0%	749,740	17.21	100%	749,740	17.21	100%	
2	-	=	0%	ų	=	0%	486,390	11.17	100%	486,390	11.17	100%	
3 ⁴	247,970	5.69	89%	-	-	0%	29,170	0.67	11%	277,140	6.36	100%	
4	-	-	0%	107,890	2.48	49%	112,380	2.58	51%	220,270	5.06	100%	
5	-	-	0%	183,870	4.22	28%	471,040	10.81	72%	654,910	15.03	100%	
6	-	=	0%	45,185	1.04	22%	158,785	3.65	78%	203,970	4.68	100%	
7	781,270	17.94	100%		-	0%	-	-	0%	781,270	17.94	100%	
TOTAL	1,029,240	23.63	31%	336,945	7.74	10%	2,007,505	46.09	60%	3,373,690	77.45	100%	

⁴ Development permitted on prior developed land per code.

SF; Square Feet

AC; Acres

0' 100' 200'

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LAND USE **SUBMITTAL**

SHEET TITLE

MASTER SITE PLAN -REGULATORY PLAN

funds are available.

limits potential development north of the railroad

restrictions on building coverage, building heights,

The Regulatory Plan results in 31 acres of 77 acres

other open space that would be provided within

development sites. The university will restore the

being dedicated to riparian restoration in addition to

riparian river edge and Millrace conservation area as

field coverage, and vehicular access and parking well

tracks by imposing a 200-foot setback and

beyond the code allowances.

describes the intent of each of these areas. It

implications, including the Willamette River ordinary

high water line, top of bank, and /WR conservation

area setback (100 feet). It establishes a 200-foot riparian enhancement setback from the top of bank

for any potential buildings and recreational fields

identifies proposed public facilities such as bike path

options, trails, viewpoints, and paddle craft launch

sites. Unless noted, all uses are permitted as in the

west of Riverfront Parkway, facilitating riparian

restoration beyond the code requirement. It

S-RP zone and /WR Overlay.

documents boundaries that have regulatory




DESCRIPTION

The Conceptual Site Plan depicts a scenario of potential maximum or likely development over the course of decades and duration of the conditional use permit. Proposed development is required to conform to the code standards and restrictions in the Regulatory Plan. The Conceptual Site Plan illustrates potential buildings and recreation fields within the development sites. The arrangement and location of buildings and fields is not intended to be precise, but the general location relative to regulatory boundaries established in the code and Regulatory Plan. North of the tracks, the building and field footprints represent the maximum footprint that might occur.
South of the tracks, the building footprints represent a likely development pattern based on typical university development that complies with the allowances in the code.

TABLE L02-1.DETAILED SITE COVERAGE

AREA ID	EXISTING BUILDING FOOTPRINT 5 To Remain			PROPOSED BUILDING FOOTPRINT					SITE ELEMENTS Open Space, Landscape, and Hardscape			CONSERVATION AREA			RIPARIAN ENHANCEMENT AREA			TOTAL			
	SF	AC	%	SF	AC	%	SF	AC	%	SF	AC	%	SF	AC	%	SF	AC	%	SF	AC	%
1	10,465	0.24	1%	192,000	4.41	26%	-	-	0%	547,275	12.56	73%	-	=	0%	-	-	0%	749,740	17.21	100%
2	80,930	1.86	17%	86,000	1.97	18%	-	-	0%	319,460	7.33	66%	-	-	0%	-	-	0%	486,390	11.17	100%
3 ⁶	-	-	0%	-	-	0%	1-	-	0%	29,170	0.67	11%	247,970	5.69	89%		-	0%	277,140	6.36	100%
4	-	-	0%	32,000	0.73	15%	-	-	0%	80,380	1.85	36%	-	-	0%	107,890	2.48	49%	220,270	5.06	100%
5	-	-	0%	3,000	0.07	0.5%	305,000	7.00	47%	163,040	3.74	25%	-	-	0%	183,870	4.22	28%	654,910	15.03	100%
6	-	-	0%	33,600	0.77	16%	-	-	0%	125,185	2.87	61%	-	-	0%	45,185	1.04	22%	203,970	4.68	100%
7	-	-	0%	-	-	0%	-	-	0%	-		0%	781,270	17.94	100%		-	0%	781,270	17.94	100%
TOTAL	91,395	2.10	2.7%	346,600	7.96	10.3%	305,000	7.00	9.0%	1,264,510	29.03	37.5%	1,029,240	23.63	30.5%	336,945	7.74	10.0%	3,373,690	77.45	100%

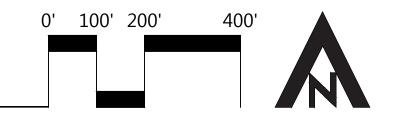

RIVERFRONT PARK SPECIAL

AREA (S-RP) ZONE

CONSERVATION AREA

ENHANCEMENT AREA ³

DEVELOPMENT SITE 2

EXISTING BUILDING

FUTURE BUILDING ¹ South of Tracks

compliant with code

FUTURE BUILDING 1 North of Tracks

FUTURE BUILDING ¹ Outside Project Area

RECREATION FIELDS 1

TOP OF BANK

SETBACK (100-ft)

VIEWPOINT 1

TABLE L02-2. PROPOSED NEW BUILDING GSF

192,000

36,000

32,000

3,000

33,600

AREA ID

1

2

3

4

5

6

7

TOTAL

SF; Square Feet

Maximum Height; Feet

GSF; Gross Square Feet

BUILDINGS

MAXIMUM

HEIGHT

85

45

15

37

960,000

180,000

96,000

100,800

1,339,800

3,000

Footprint

Building footprint scenario

Maximum Potential Building

PHYSICAL EDUCATION AND

ORDINARY HIGH WATER

CONSERVATION AREA

BIKE PATH OPTIONS 1

RIPARIAN ENHANCEMENT AREA SETBACK (200-ft)

PADDLE CRAFT LAUNCH 1

PARKING STRUCTURE 1

REQUIRED

RIPARIAN

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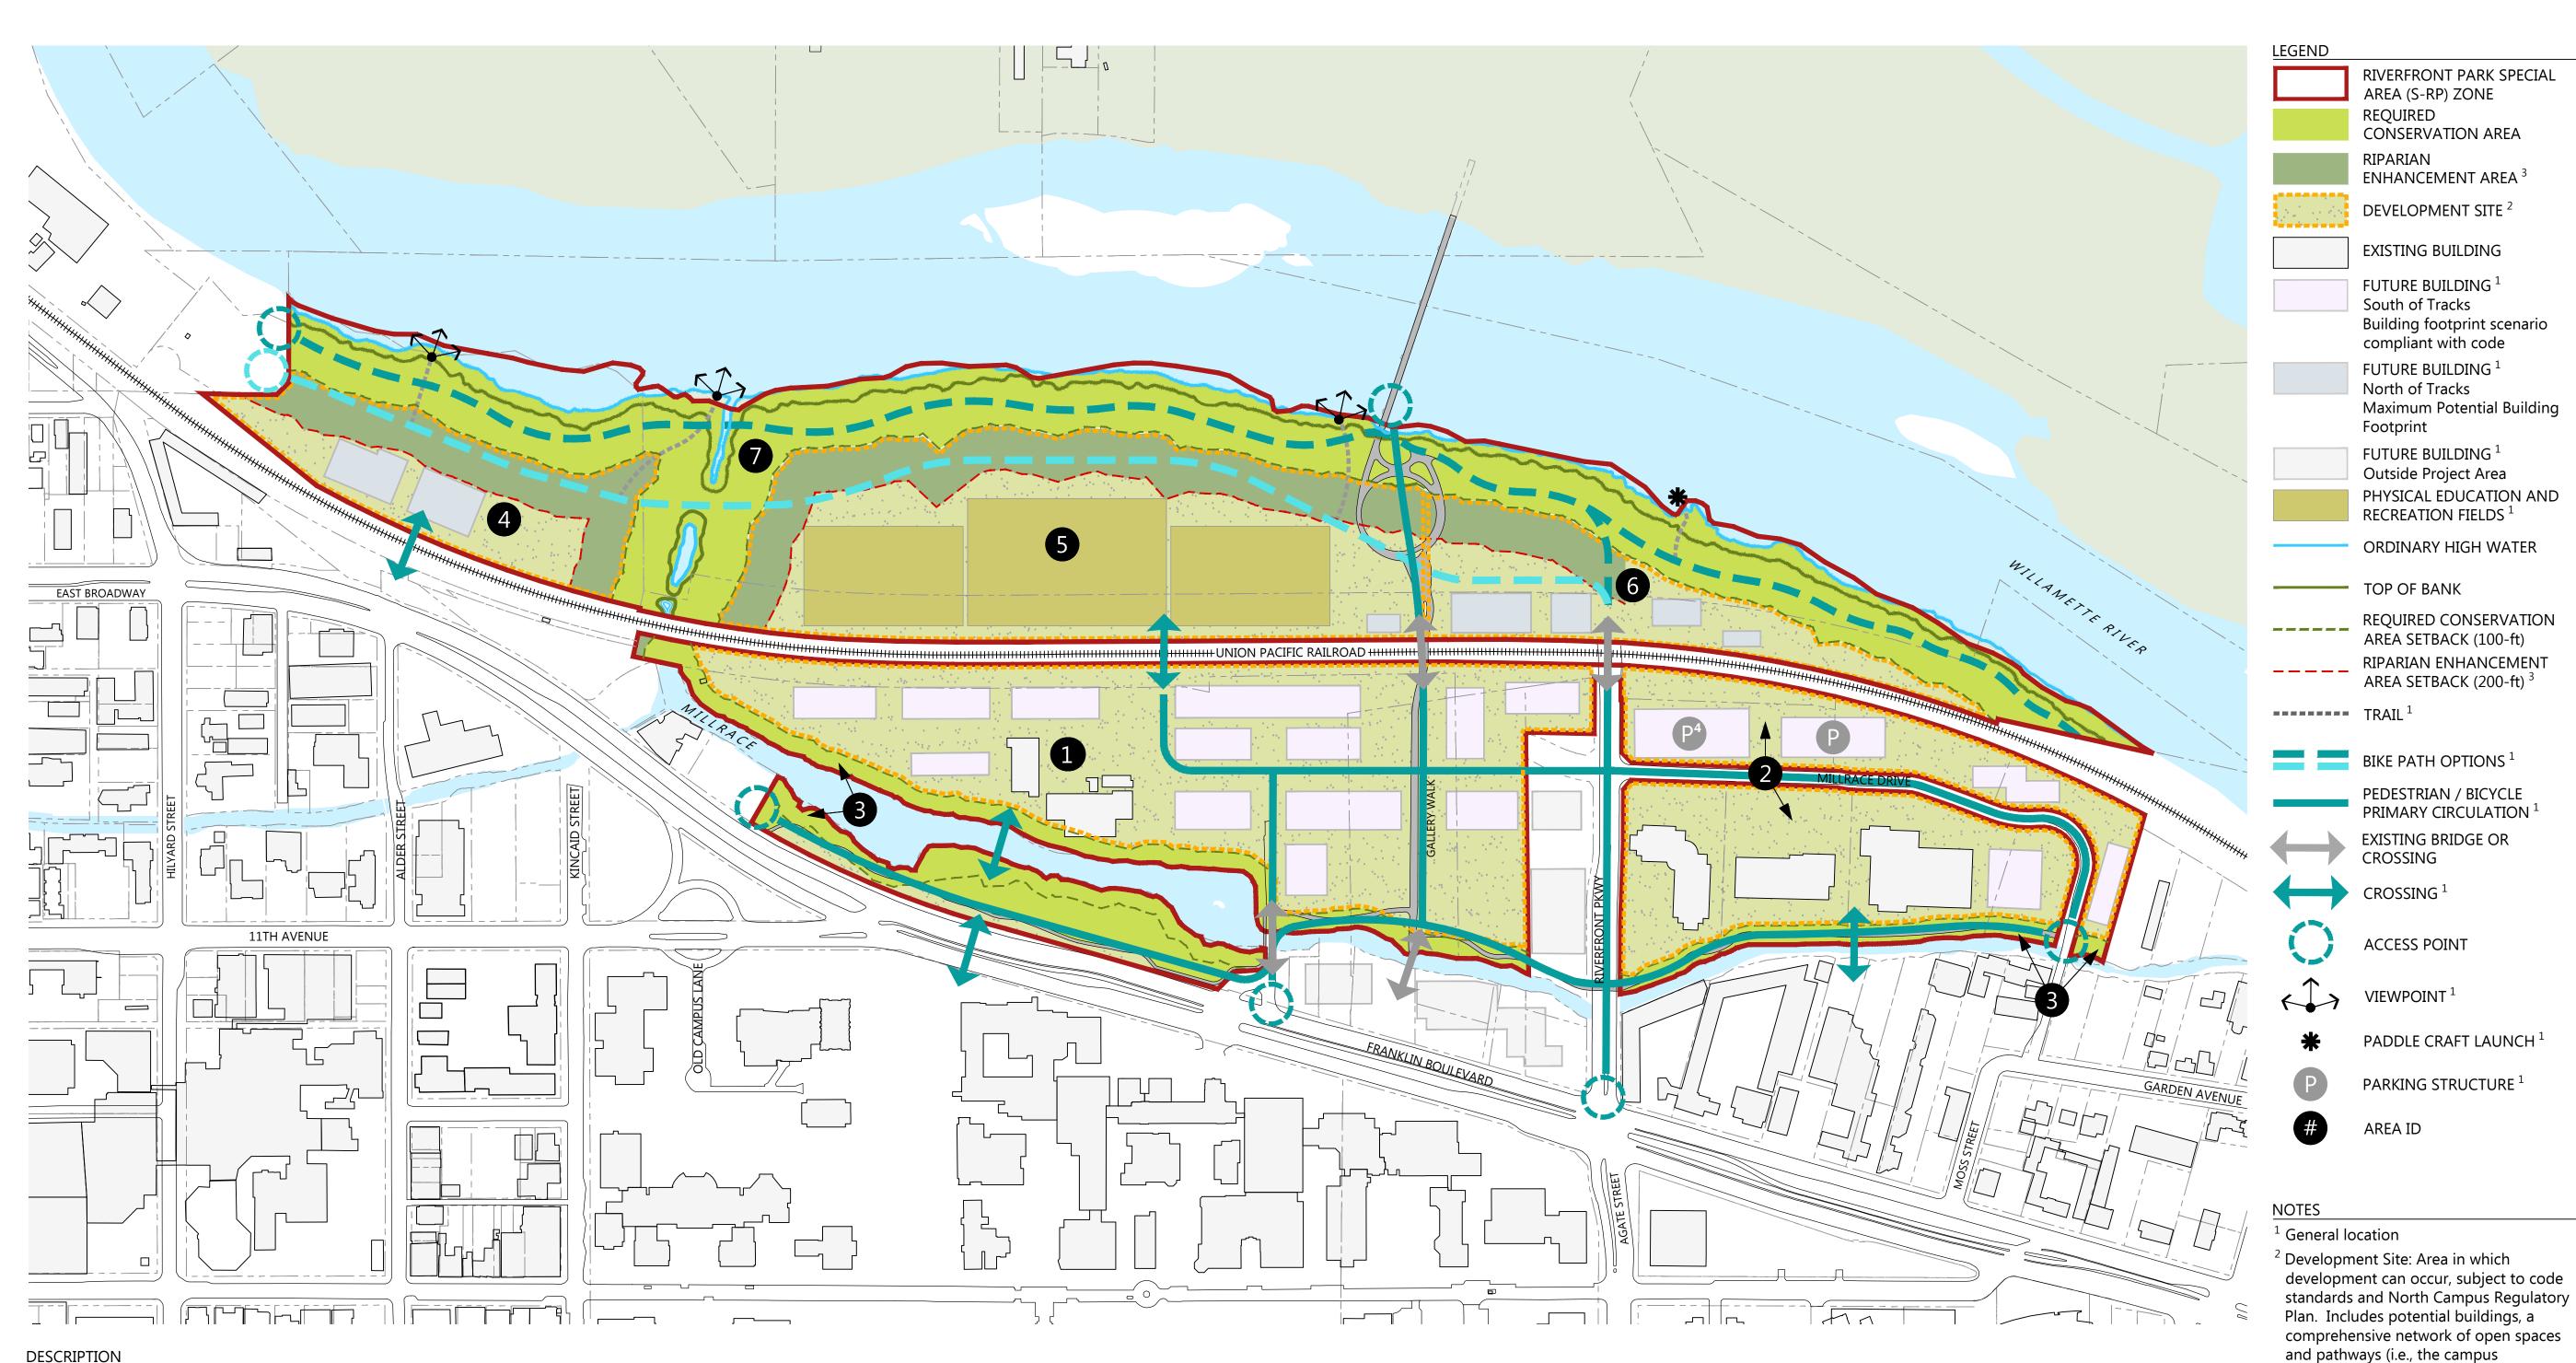
MASTER SITE PLAN -SITE PLAN

⁵ Power station in Area 1 existed prior to May 11, 1987 and is excluded from coverage calculations per code. Research park buildings in Area 2 were built after May 11, 1987 and are included in coverage calculations.

⁶ Some developments may occur on prior developed land as allowed per code.

SF; Square Feet AC; Acres

CONCEPTUAL SITE PLAN



DESCRIPTION

The Pedestrian and Bicycle Primary Circulation Plan illustrates primary circulation routes, access points, and crossings that the university proposes to maintain or provide. It depicts the general location of these elements and the direction of travel for the primary routes. It does not depict all paths that would be part of the circulation system, as those would be determined during the design process of a development project. This plan includes two proposed alignment options for the Ruth Bascom Riverfront Path, one that shows the path closer to the river's edge and one that shows it further. This is not for the purpose of constructing two bike paths, but rather to allow for flexibility in the placement of the bike path at the time of an actual project. The features of each alignment could be interchangeable.

0' 100' 200' 400'

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RIVERFRONT PARK SPECIAL

AREA (S-RP) ZONE

CONSERVATION AREA

ENHANCEMENT AREA 3

DEVELOPMENT SITE ²

EXISTING BUILDING

FUTURE BUILDING 1 South of Tracks

compliant with code

FUTURE BUILDING 1 North of Tracks

FUTURE BUILDING 1 Outside Project Area

RECREATION FIELDS 1

TOP OF BANK

ORDINARY HIGH WATER

REQUIRED CONSERVATION AREA SETBACK (100-ft)

RIPARIAN ENHANCEMENT AREA SETBACK (200-ft) 3

BIKE PATH OPTIONS ¹

PEDESTRIAN / BICYCLE PRIMARY CIRCULATION ¹

EXISTING BRIDGE OR

CROSSING

CROSSING 1

VIEWPOINT 1

AREA ID

open-space framework), and all site

uses, such as but not limited to

public art.

⁴ Known Project

elements associated with permitted

landscape, pathways, site furniture,

transportation circulation, utilities, and

³ Riparian Enhancement Area and Setback:

No buildings or recreational fields

permitted within this setback.

ACCESS POINT

PADDLE CRAFT LAUNCH 1

PARKING STRUCTURE 1

Footprint

Building footprint scenario

Maximum Potential Building

PHYSICAL EDUCATION AND

REQUIRED

RIPARIAN

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SHEET TITLE

MASTER SITE PLAN -PEDESTRIAN AND **BICYCLE PRIMARY** CIRCULATION PLAN

SHEET #



The Private Vehicle Circulation Plan illustrates primary circulation for private vehicles, managed access, and primary access points that the university proposes to maintain or provide. Private vehicle circulation is synonymous with unrestricted access. Managed access is synonymous with access for loading/unloading and ADA needs associated with buildings and uses in those areas. It does not depict all routes that would be part of the circulation system, as those would be determined during the design process of a development project.

development can occur, subject to code standards and North Campus Regulatory Plan. Includes potential buildings, a comprehensive network of open spaces open-space framework), and all site elements associated with permitted uses, such as but not limited to landscape, pathways, site furniture, transportation circulation, utilities, and public art.

³ Riparian Enhancement Area and Setback: No buildings or recreational fields permitted within this setback.

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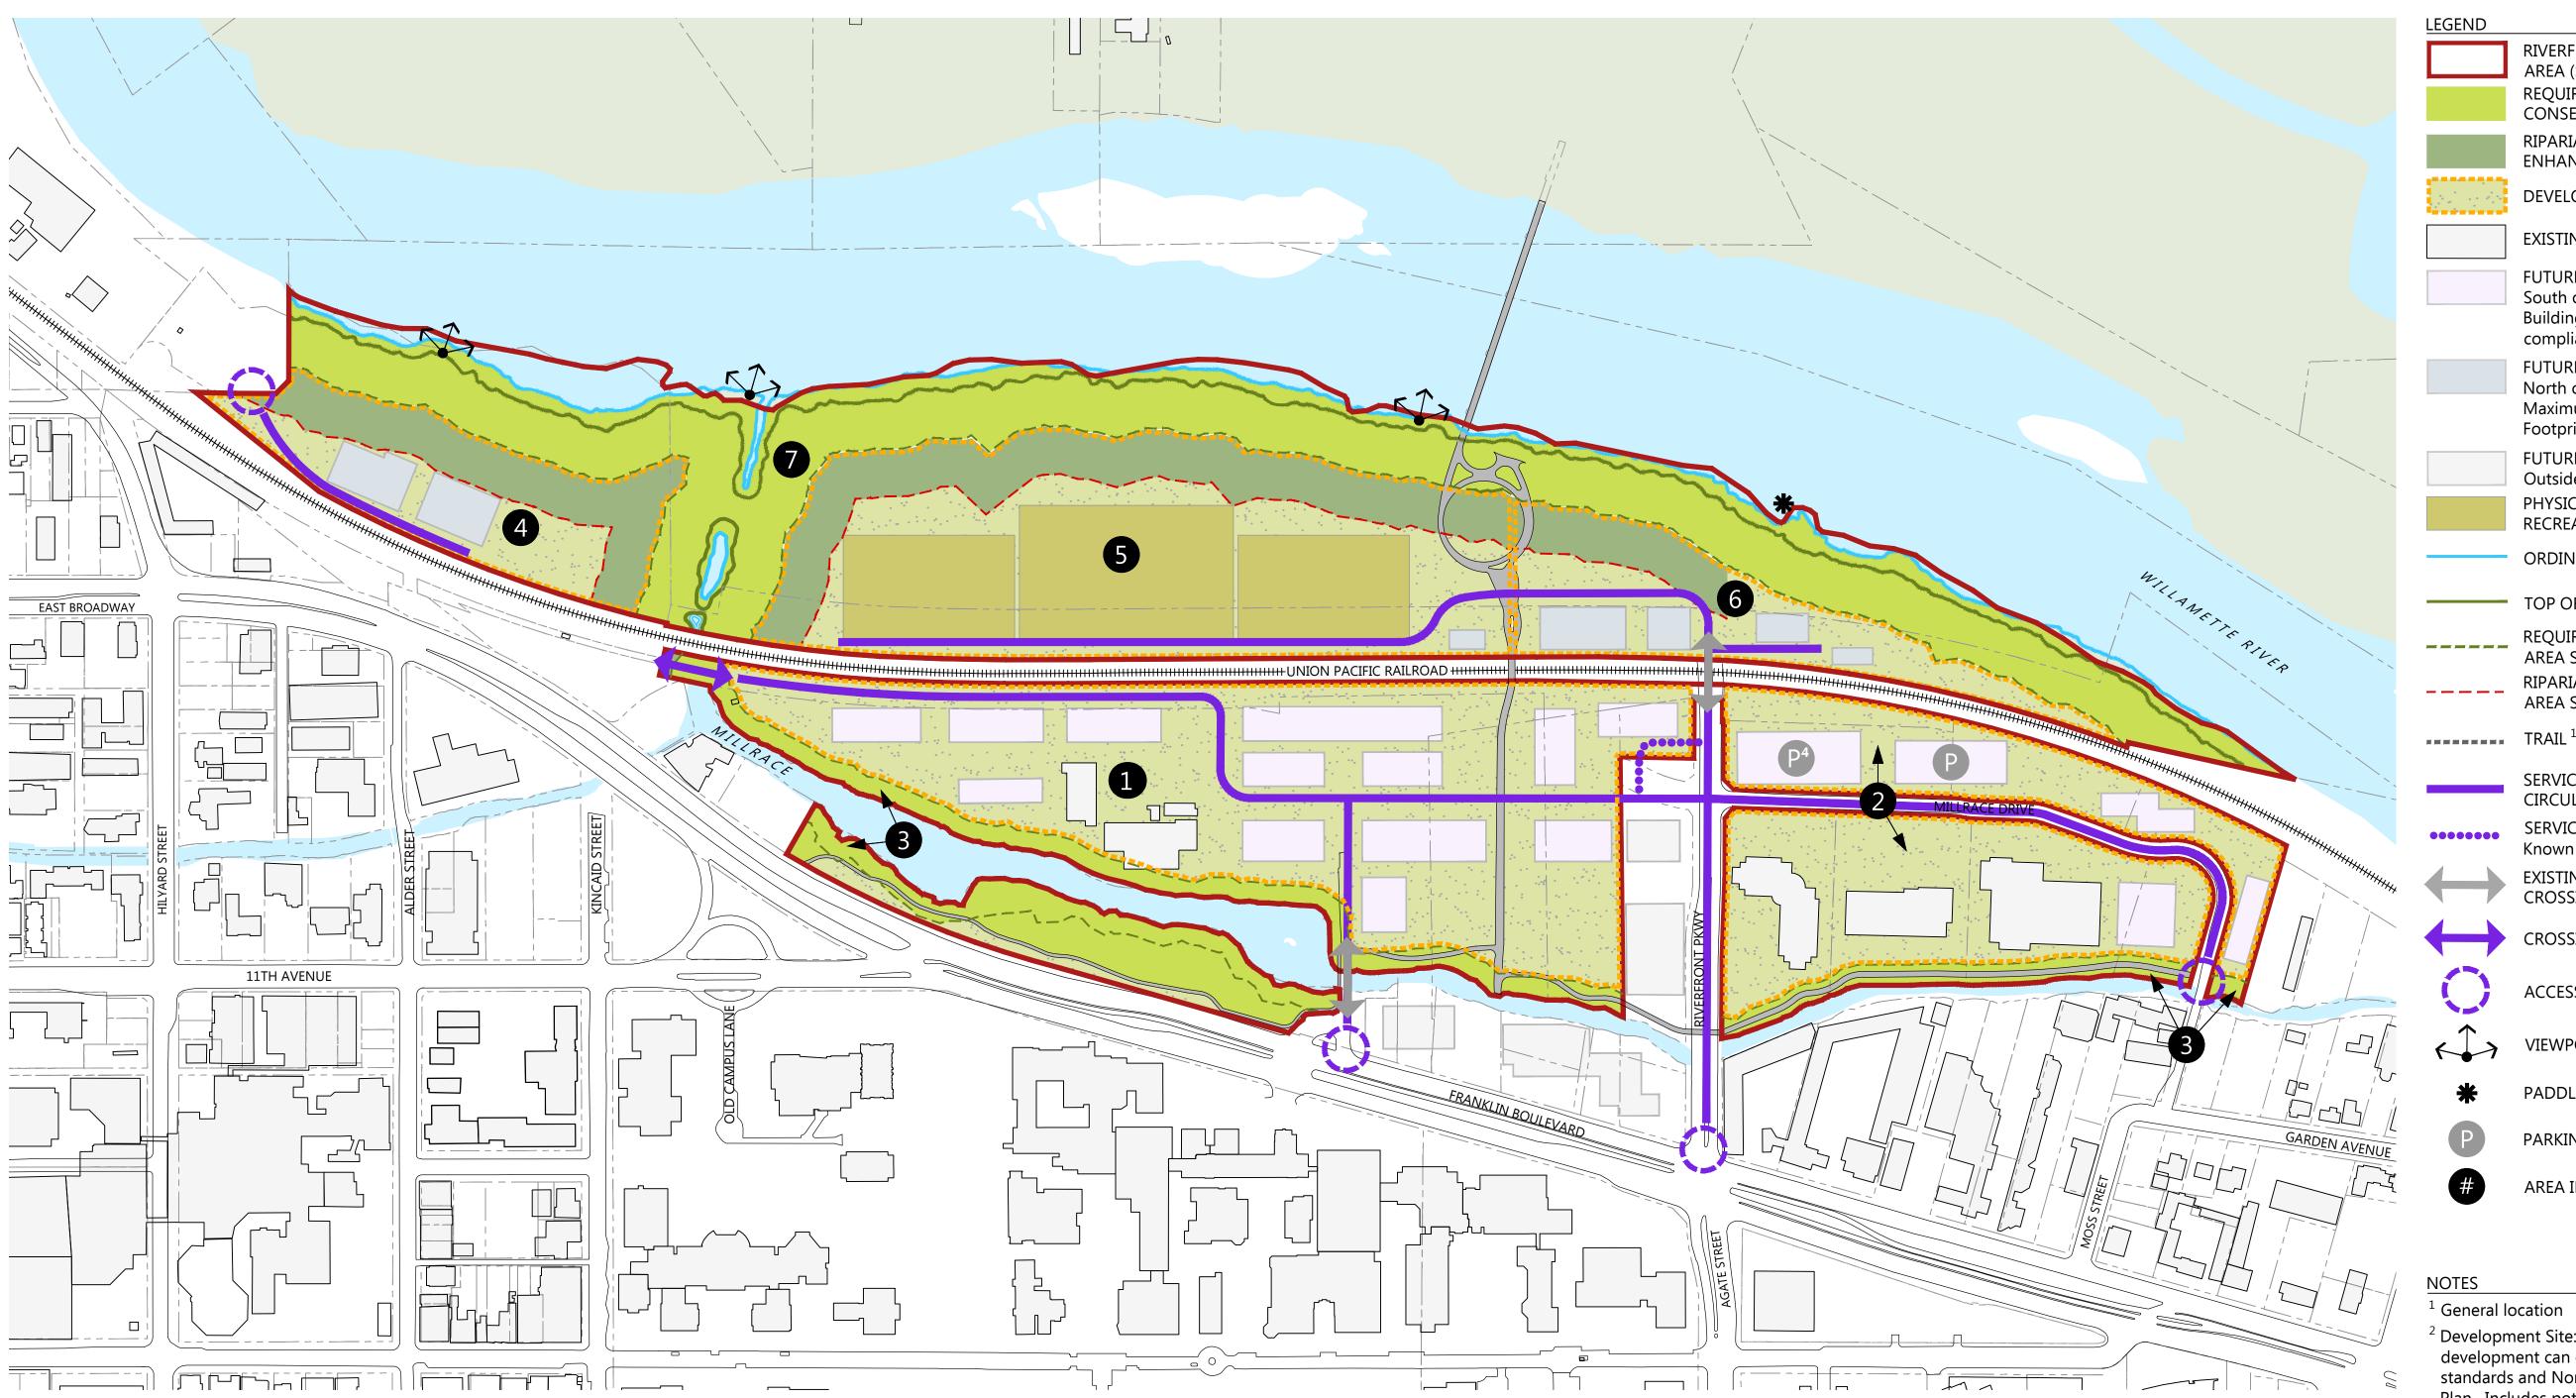
LAND USE SUBMITTAL

SHEET TITLE

MASTER SITE PLAN -PRIVATE VEHICLE PRIMARY CIRCULATION PLAN

0' 100' 200' 400'

⁴ Known Project



DESCRIPTION

The Service Vehicle Primary Circulation Plan illustrates primary routes, access points, and crossings for service and delivery vehicles, police vehicles, and emergency vehicles that the university proposes to maintain or provide. It depicts the general location of these elements and the direction of travel for the primary routes. It does not depict all routes that would be part of the circulation system, as those would be determined during the design process of a development project.

NOTES ¹ General location

> ² Development Site: Area in which development can occur, subject to code standards and North Campus Regulatory Plan. Includes potential buildings, a comprehensive network of open spaces and pathways (i.e., the campus open-space framework), and all site elements associated with permitted uses, such as but not limited to landscape, pathways, site furniture, transportation circulation, utilities, and public art.

> ³ Riparian Enhancement Area and Setback: No buildings or recreational fields permitted within this setback.

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RIVERFRONT PARK SPECIAL

AREA (S-RP) ZONE

CONSERVATION AREA

ENHANCEMENT AREA ³

DEVELOPMENT SITE ²

EXISTING BUILDING

FUTURE BUILDING 1 South of Tracks

compliant with code

FUTURE BUILDING 1 North of Tracks

FUTURE BUILDING 1 Outside Project Area

RECREATION FIELDS 1

TOP OF BANK

CIRCULATION 1

Known Project

CROSSING

CROSSING 1

ACCESS POINT

PADDLE CRAFT LAUNCH 1

PARKING STRUCTURE 1

VIEWPOINT 1

AREA ID

EXISTING BRIDGE OR

Footprint

Building footprint scenario

Maximum Potential Building

PHYSICAL EDUCATION AND

ORDINARY HIGH WATER

REQUIRED CONSERVATION AREA SETBACK (100-ft)

RIPARIAN ENHANCEMENT AREA SETBACK (200-ft) ³

SERVICE VEHICLE PRIMARY

SERVICE VEHICLE CIRCULATION 1

REQUIRED

RIPARIAN

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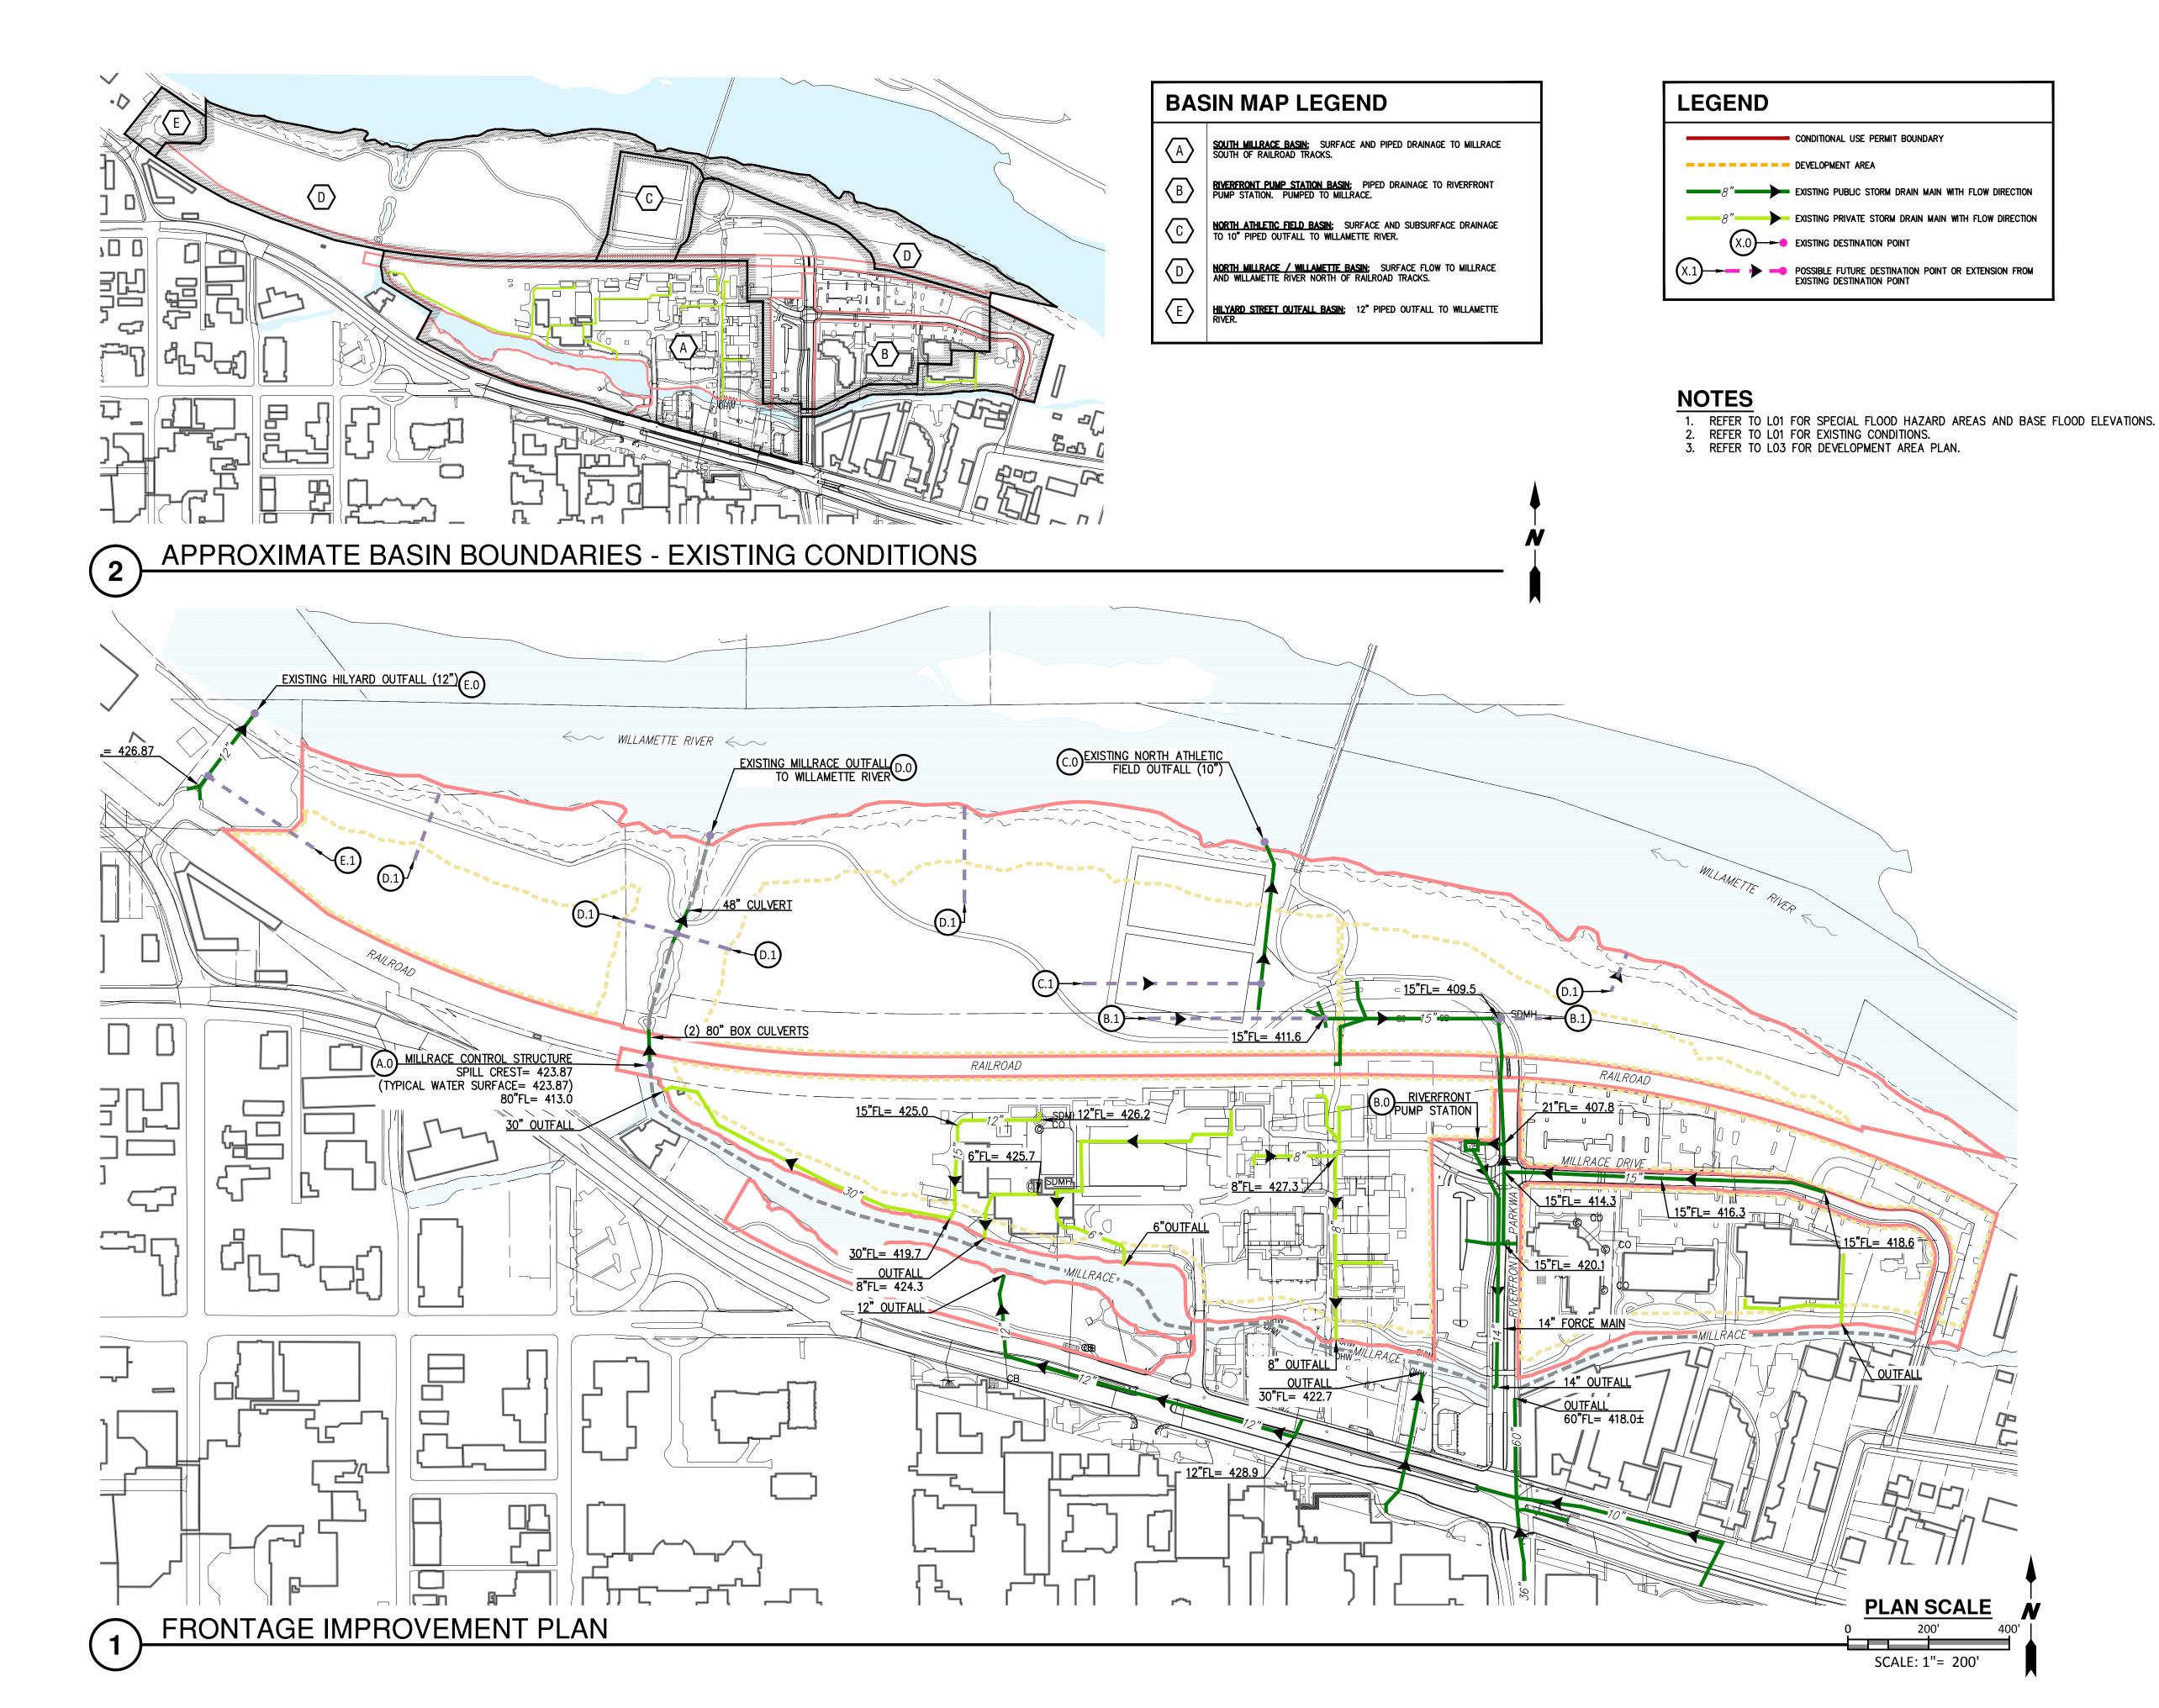
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SHEET TITLE

MASTER SITE PLAN -SERVICE VEHICLE PRIMARY CIRCULATION PLAN

⁴ Known Project



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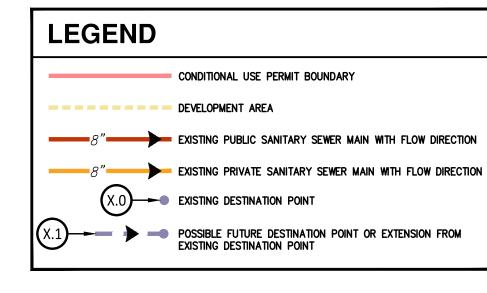
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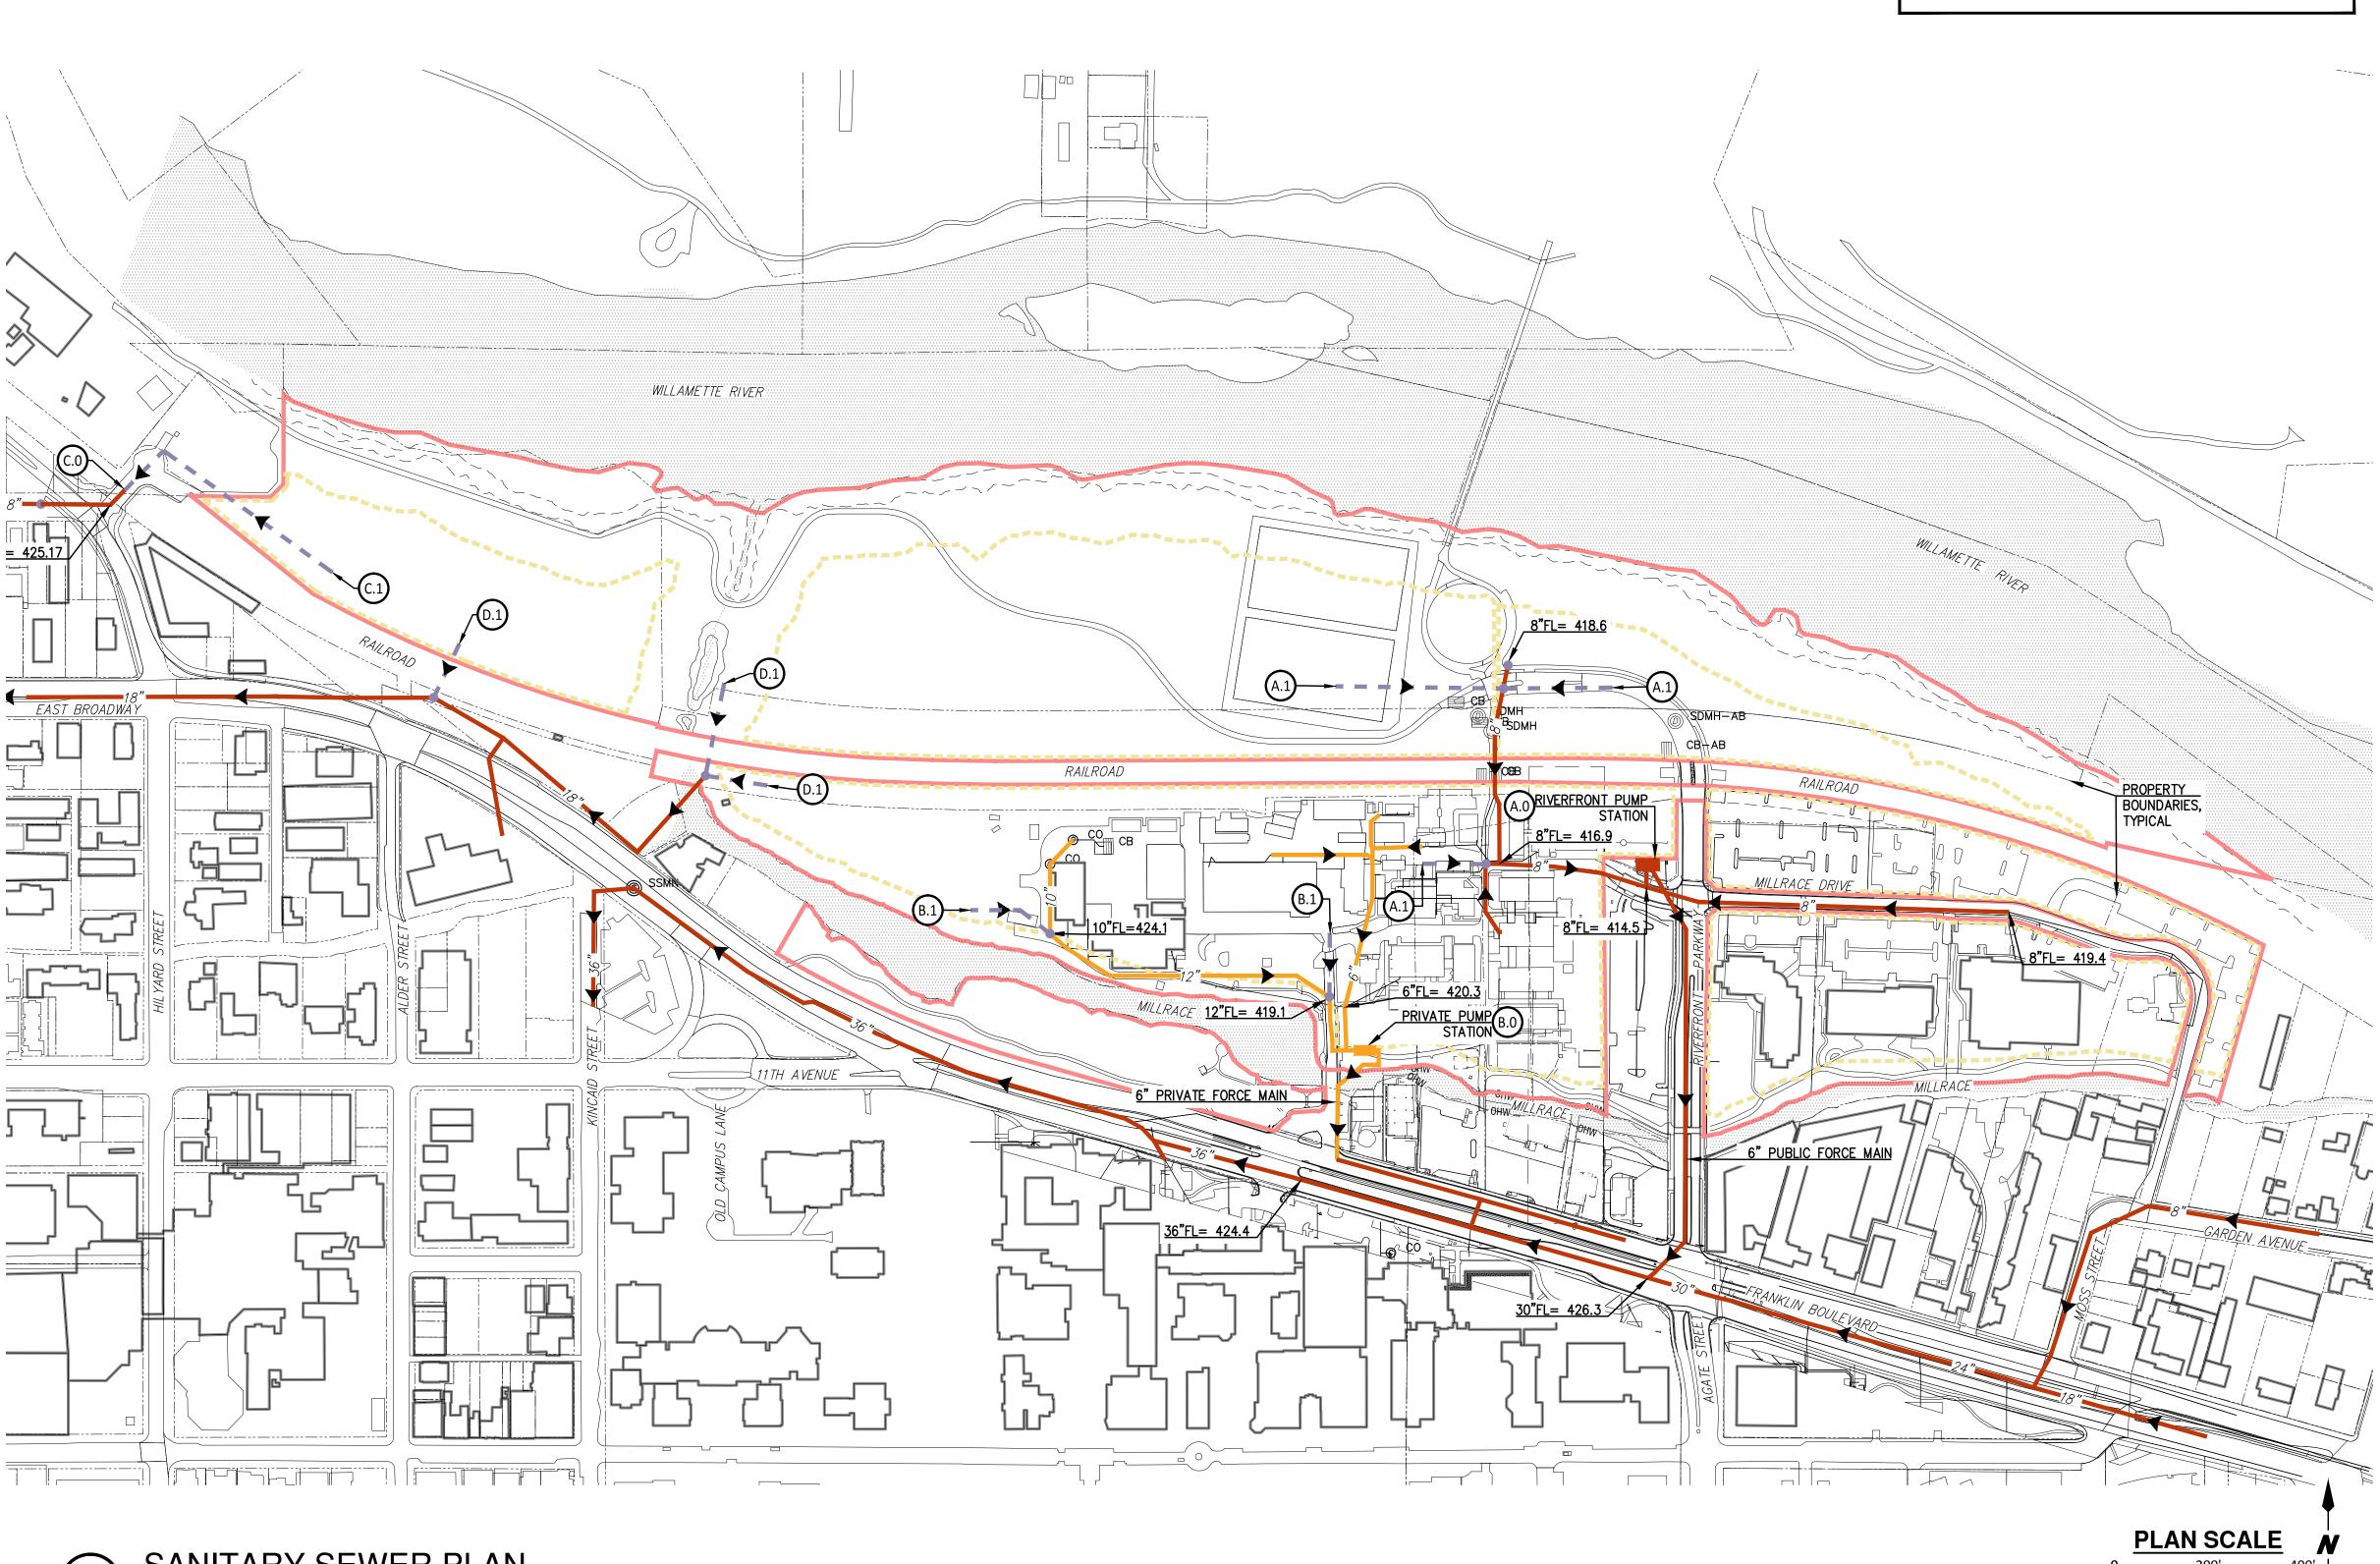
SHEET TITLE

STORM DRAIN PLAN

SHEET #

C01





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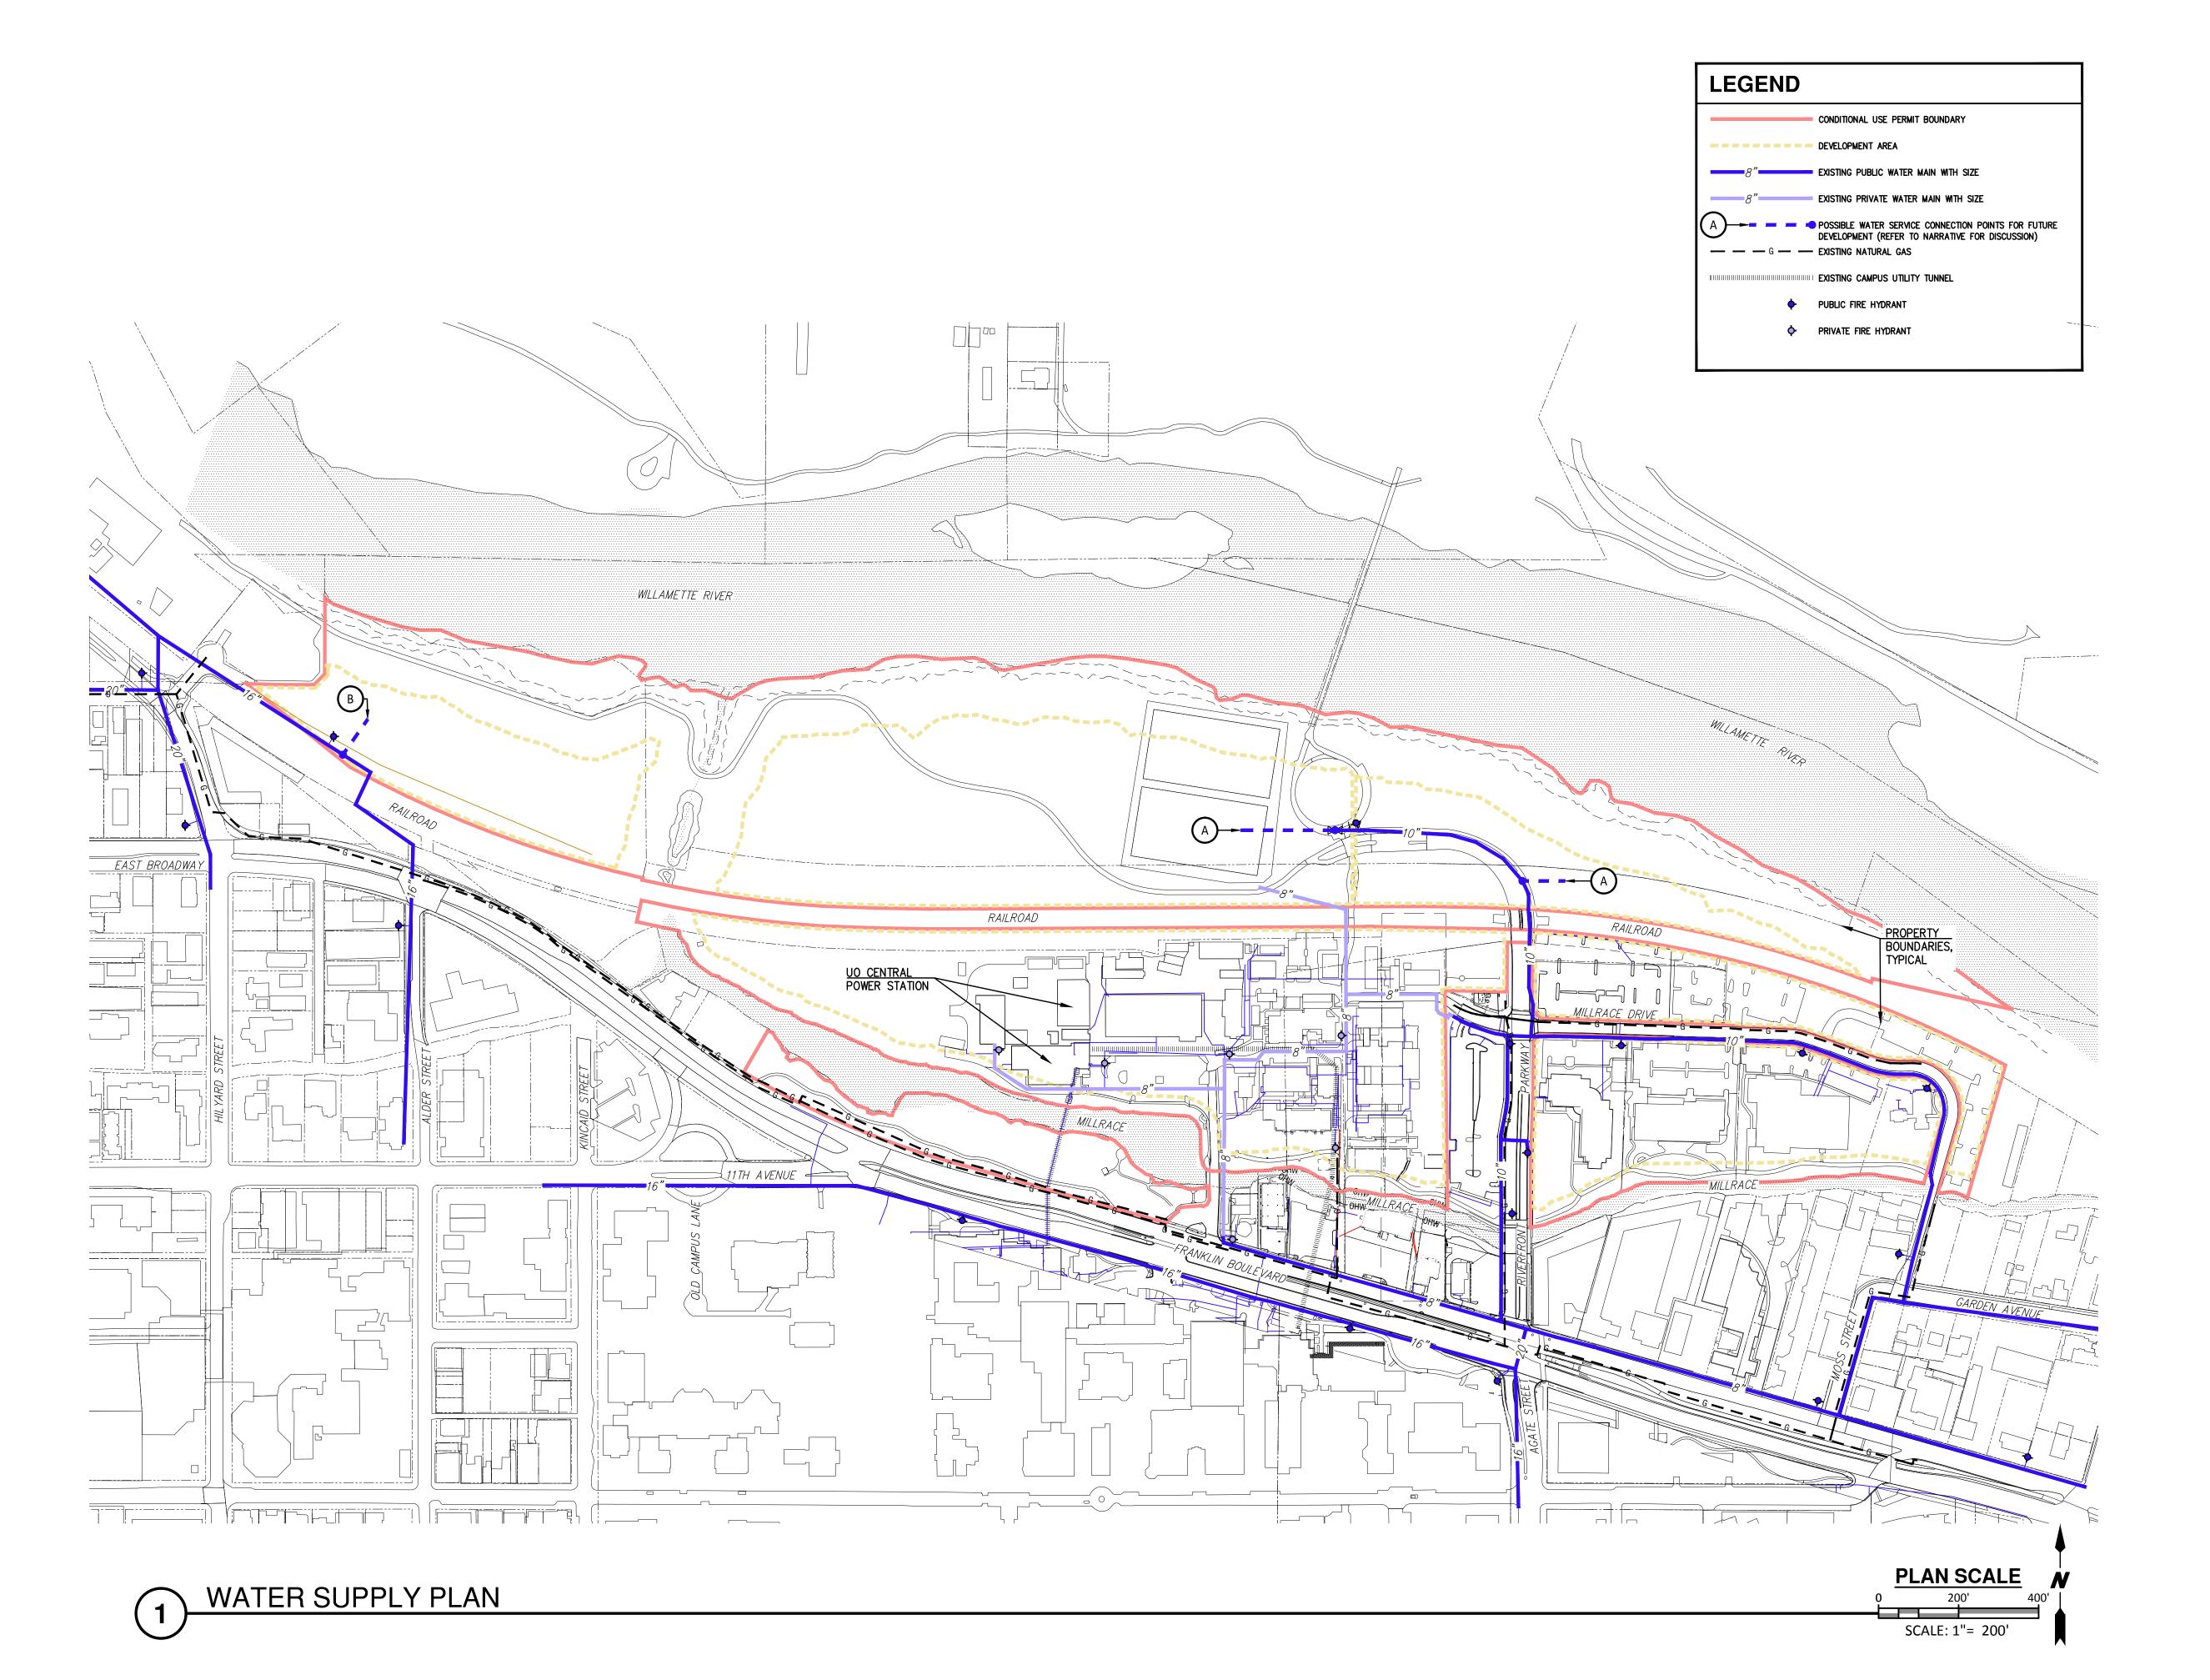
SHEET TITLE

SANITARY SEWER PLAN

SHEET #

SCALE: 1"= 200'

C02



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WATER SUPPLY PLAN

SHEET #

C03